# HYDRAULIC ENGINEERING PLAN

PROJECT: PROPOSED NEW GRANNY FLAT

ADDRESS: 1489 CANTERBURY ROAD, PUNCHBOWL


LGA: CANTERBURY-BANKSTOWN COUNCIL

LIST OF DRAWING		
SHEET NO	DRAWING NAME	
GN0	COVER PAGE	
0E0	EROSION AND SEDIMENT CONTROL PLAN	
0L1	GROUND FLOOR PLAN	
RL1	ROOF PLAN	
SD1 STANDARD DETAILS		
SD2 STANDARD DETAILS (CONT'D)		

#### **GENERAL NOTES**

- 1. THE PLUMBER/ DRAINER SHALL INSPECT THE SITE AND CONFIRM THE EXISTING SITE STRUCTURES, SERVICES AND CONDITIONS PRIOR TO PROCEEDING. IF ANY DISCREPANCIES FOUND, CONTACT THE ENGINEER FOR DISCUSSION.
- 2. ALL WORKS TO BE CARRIED OUT IN ACCORDANCE WITH RELEVANT AUSTRALIAN STANDARDS. BUILDING CODE OF AUSTRALIA AND LOCAL GOVERNMENT'S REQUIREMENTS. IT IS THE RESPONSIBILITY OF THE PLUMBER/ DRAINER TO OBTAIN ANY APPROVALS/ PERMITS/ LICENSES ISSUED BY THE AUTHORITIES PRIOR TO PROCEEDING WITH STORMWATER WORKS PROCEEDING WITH STORMWATER
- 3. UNLESS NOTED AS OTHERWISE, ALL DOWNPIPES TO BE Ø100 ROUND (OR 100x75 RECTANGULAR) AND FULLY SEALED. ALL EAVE GUTTERS TO BE 115 QUAD HI-FRONT OR EQUIVALENT, ALL BOX GUTTERS TO BE 200Wx150H. ALL STORMWATER PIPES TO BE Ø100 SEWER GRADE AND LAID AT 1% MIN. FALL. ALL MATERIALS USED IN THE WORK SHALL BE NEW AND CONFORM WITH RELEVANT AUSTRALIAN STANDARDS AND BEAR THE REQUIRED STANDARDS MARK.
- 4. LOCATION OF STORMWATER SYSTEMS, INCLUDING DOWNPIPES, PIPES, PITS AND RAINWATER TANK ARE INDICATIVE ONLY. EXACT LOCATION SHALL BE DETERMINED ON SITE TO SUIT SITE
- 5. SUB-SOIL DRAINS FOR RETAINING WALL SHALL BE INSTALLED BY THE BUILDER AND CONNECTED TO STORMWATER LINES, ALL AGG, LINES SHALL BE 100mm DIA., UNLESS NOTED OTHERWISE.
- 6 NATURAL GROUND LEVELS ALONG ALL BOUNDARIES MUST BE MAINTAINED UNALTERED, ALL RETAINING WALLS TO BE SETBACK FROM BOUNDARIES TO AVOID CONCENTRATION OF STORMWATER FLOWS.
  7. LEVELS ARE APPROXIMATE ONLY. THE PLUMBER/ DRAINER SHALL CONFIRM THE LEVELS PRIOR TO
- PROCEEDING. IF ANY DISCREPANCIES FOUND, CONTACT THE ENGINEER FOR DISCUSSION.
- 8. INSPECTION AND CERTIFICATION, IF REQUIRED, SHALL BE DONE PRIOR TO BACKFILLING. ALLOW 24 HOUR NOTICE FOR THE ENGINEER TO CARRY OUT INSPECTION.
- 9. ANY DAMAGE TO SERVICES DURING CONSTRUCTION SHALL BE REPAIRED IMMEDIATELY AT THE PLUMBER/ DRAINER'S OWN EXPENSE.
- 10. RWT TO BE WATERPROOFED TO AS 3500.1:2018, AS 3735:2001 AND AS 4766:2006 AS APPLICABLE.

EXISTING IMPERVIOUS AREA		
Name	Area	
IMPERVIOUS AREA	296 m²	
PERVIOUS AREA	237 m²	
TOTAL SITE AREA	533 m²	

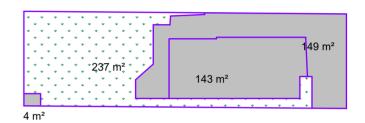

#### **EXISTING SITE PLAN (AREA)**

SCALE: 1:500

IMPERVIOUS AREA PERVIOUS AREA





#### PROPOSED SITE PLAN (AREA)

1. IF ANY DISCREPANCIES OR DOUBTS, CONTACT THE ENGINEER. 2. BOOKINGS FOR INSPECTION, IF REQUIRED, SHALL BE MADE VIA OUR WEBSITE AT www.nitma.com.au/bookings. CONDITIONS APPLY

4

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Original issue Designed: NL Checked: HN

Approved: Quoc Huy Nguyen PhD (Eng). MIEAust, CPEng, NER Reg. No. 208 2513


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PROJECT: PROPOSED NEW GRANNY FLAT ADDRESS: 1489 CANTERBURY ROAD, PUNCHBOWL CANTERBURY-BANKSTOWN COUNCIL

Project No: 6797H

COVER PAGE

9 Total no. of sheets Issue: A Date: 20.11.2024 Drawing No: GN0

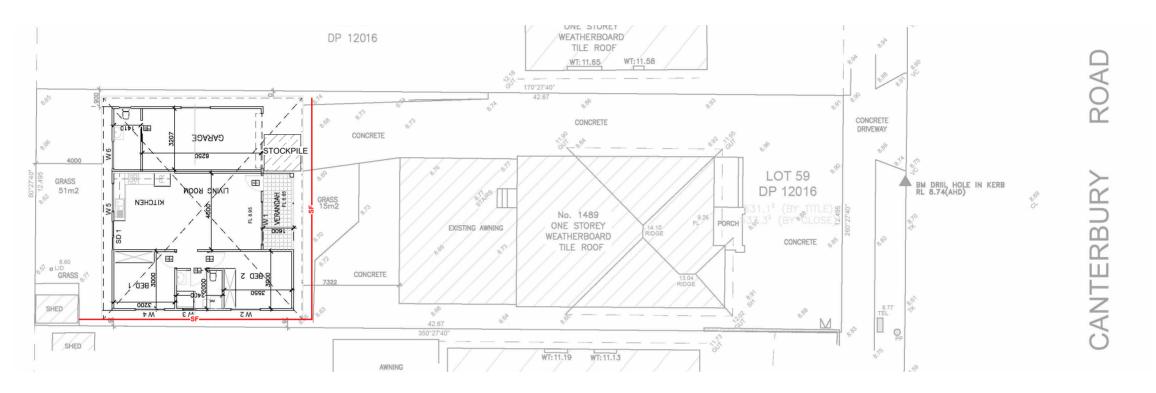


#### **EROSION & SEDIMENT CONTROL PLAN**

SCALE: 1:200

#### NOTES:

- 1. ALL EROSION AND SEDIMENT CONTROL MEASURES TO BE INSPECTED AND MAINTAINED DAILY BY SITE MANAGER
- 2. MINIMISE DISTURBED AREA
- 3. ALL STOCKPILES TO BE CLEAR FROM DRAINS, GUTTERS AND FOOTPATH
- 4. DRAINAGE IS TO BE CONNECTED TO STORMWATER SYSTEM AS SOON AS POSSIBLE
- 5. ROADS AND FOOTPATH TO BE SWEPT DAILY
- 6. KERB SIDE INLET TO BE PROTECTED WITH FABRIC FILLED WITH GRAVEL
- 7. NON-COMPLIANCE MAY INCUR PENALTY



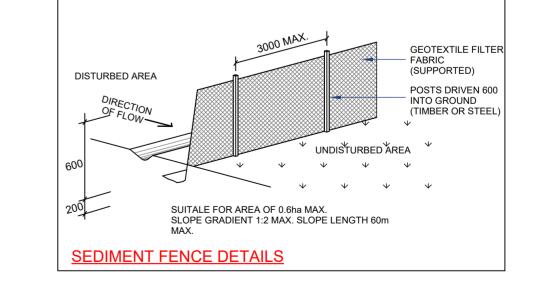



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Revisions		
Original issue		
Designed: NL	Checked: HN	

Approved:

Quoc Huy Nguyen
PhD (Eng). MIEAust, CPEng,
NER Reg. No. 208 2513

C O N S U L T I N G


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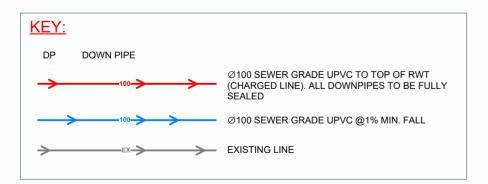
PROJECT: PROPOSED NEW GRANNY FLAT ADDRESS: 1489 CANTERBURY ROAD, PUNCHBOWL LGA: CANTERBURY-BANKSTOWN COUNCIL

**EROSION AND SEDIMENT CONTROL PLAN** 

Project No: 6797H Issue: A Date: 20.11.2024 Drawing No: 0E0



#### **DRAINAGE PLAN - ROOF PLAN** SCALE: 1:200

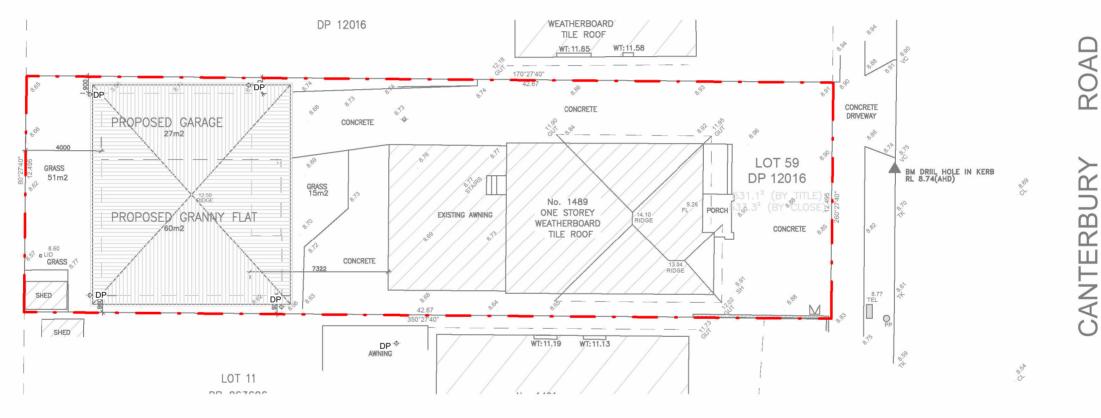

**A3** 

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Revisions		
Original issue		
Designed: NL	Checked: HN	

Quoc Huy Nguyen PhD (Eng). MIEAust, CPEng, NER Reg. No. 208 2513 CONSULTING


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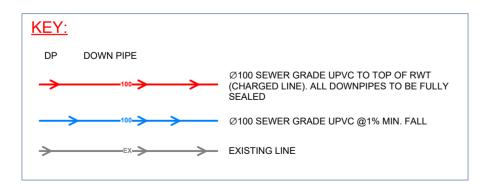
**ROOF PLAN** 

Issue: A Date: 20.11.2024 Drawing No: RL1 Project No: 6797H



TANK SIZING					
	TANK	HEIGHT	LENGTH	WIDTH	VOLUME
	RWT/OSD	1860	2200	800	3.00 m <sup>3</sup>

#### DRAINAGE PLAN - GROUND FLOOR PLAN SCALE: 1:200

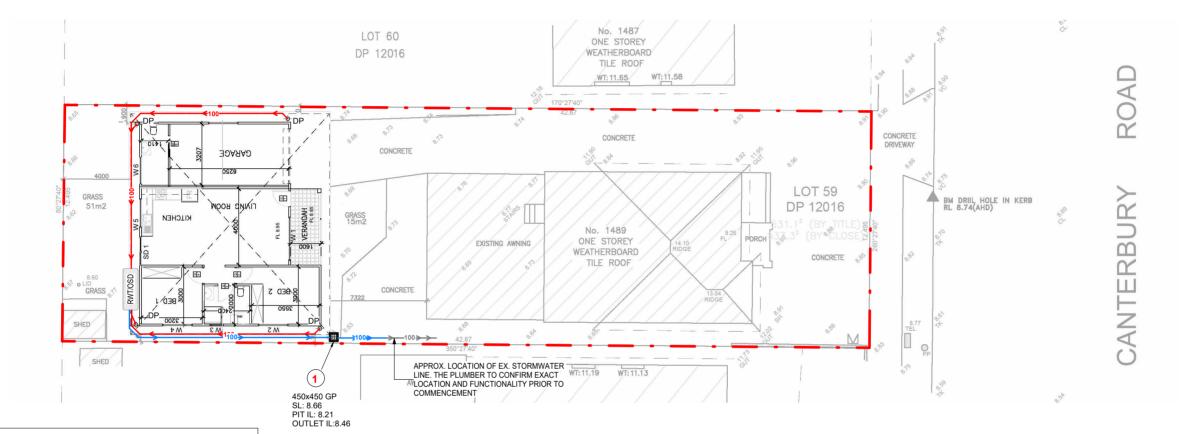

A3

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Re	evisions
Original issue	
Designed: NL	Checked: HN



Approved:

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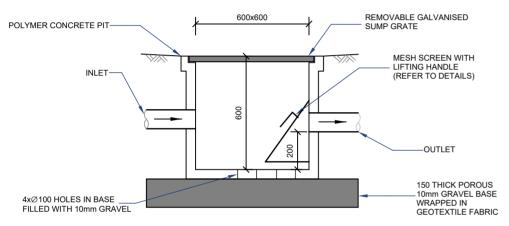
PROJECT: PROPOSED NEW GRANNY FLAT ADDRESS: 1489 CANTERBURY ROAD, PUNCHBOWL : CANTERBURY-BANKSTOWN COUNCIL

**GROUND FLOOR PLAN** 


Issue: A Date: 20.11.2024 Drawing No: 0L1 Project No: 6797H

#### SILT ARRESTOR PIT NOTES:

- 1. MESH SCREEN IS TO BE GALVANISED LYSAGHT RH3030 MAXI MESH COVERED WITH GEOTEXTILE IN GALVANISED STEEL FRAME WITH LIFTING HANDLES ACROSS BASE.
- 2. GEOTEXTILE IS TO BE BIDIM A14, PROPEX 4550 OR SIMILAR WITH COEFFICIENT OF PERMEABILITY GREATER THAN 50E-4m/s.





## SILT ARRESTOR PIT DETAILS

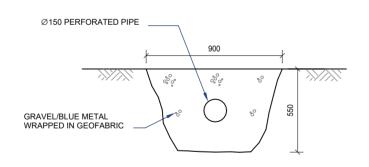

#### LEVEL SPREADER DETAILS


SCALE: 1:25

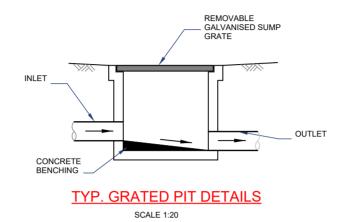


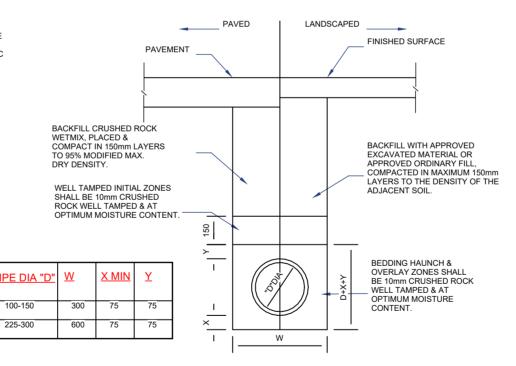

#### UPVC PIPE TRENCH BACKFILL TYP. DETAILS

SCALE 1:20

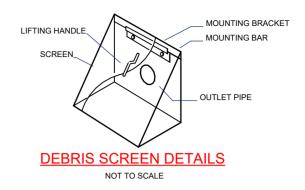

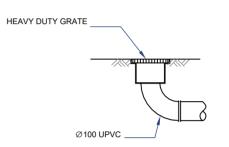

#### **GRATED BOX DRAIN DETAILS**

MINIMUM PIPE COVER	MIN	<u>IMUM</u>	PIPE	COVE
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(FROM FINISHED SURFACE TO TOP OF PIPE)

(FROM FINISHED SURFACE TO TOP OF PIPE)			
	MINIMUM COVER (mm)		
LOCATION	CAST/DUCTILE IRON GAL STEEL	OTHER AUTHORISED PRODUCTS (~)	
1. NOT SUBJECT TO VEHICULAR LOADING:			
A. WITHOUT PAVEMENT			
i. FOR SINGLE DWELLING	0	100	
ii. OTHER THAN SINGLE DWELLING	0	300	
B. WITH PAVEMENT OF	0( )	50( )	
BRICK/UNREINFORCED CONCRETE  2. SUBJECT TO VEHICULAR LOADING:	0(~~)	50(~~)	
A. OTHER THAN ROAD:	300	450	
i. WITHOUT PAVEMENT			
ii. WITH PAVEMENT OF:	0(~~#)	100(~~#)	
- REIFORCED CONC. FOR HEAVY	0(~~#)	75(~~#)	
VEHICLE			
- BRICK/UNREINF. CONC. LIGHT	300 300	500(#)	
VEHICLE	300	500(#)	
B. ROAD			
i. SEALED	300	500(#)	
ii. UNSEALED			
3. SUBJECT TO CONSTRUCTION VEHICLE OR IN ENBANKMENT CONDITION			

(~) INCLUDES OVERLAY ABOVE THE TOP OF THE PIPE OF NOT LESS THAN 50mm THICK (~~) BELOW THE UNDERSIDE OF THE PAVEMENT (#) SUBJECT TO COMPLIANCE WITH AS1762, AS2033, AS/NZS2566.1, AS3725 OR AS4060

4

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Revisions Original issue Designed: NL Checked: HN

Approved:

Quoc Huy Nguyen PhD (Eng). MIEAust, CPEng, NER Reg. No. 208 2513



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PROJECT: PROPOSED NEW GRANNY FLAT ADDRESS: 1489 CANTERBURY ROAD, PUNCHBOWL : CANTERBURY-BANKSTOWN COUNCIL

STANDARD DETAILS


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#### OSD REQUIREMENTS

AN OSD OF 2000L IS REQUIRED FOR THIS DEVELOPEMENT UNDER BAXIS CERTIFICATE. A RWT OF 2000 L IS PROVIDED

#### **RWT REQUIREMENTS**

A RWT OF 1000L IS REQUIRED FOR THIS DEVELOPEMENT UNDER BAXIS CERTIFICATE. A RWT OF 10000 L IS PROVIDED

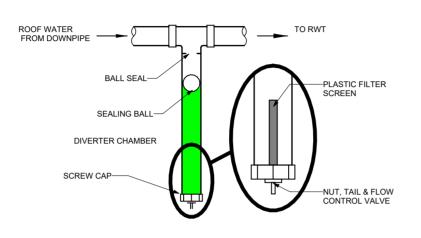

FIRST FLUSH
DEVICE (REFER TO DETAILS)

RAINWATER TANK
(REFER TO DETAILS)

AUTOMATIC MAINS
WATER DIVERSION
REASSEMBLED UNIT
WITH PUMP & WATER
SWITCH

Ø 100 SEWER
GRADE OVERFLOW

#### FIRST FLUSH DEVICE DETAILS

NOT TO SCALE

## ABOVEGROUND RWT INSTALLATION


SCALE 1:50

#### **RAINWATER TANK NOTES:**

- 1. RAINWATER TANKS BY TANKWORKS AUSTRALIA (TEL: 1300 736 562) OR SIMILAR
- 2. DIMENSIONS ARE INDICATIVE ONLY. EXACT DETAILS TO MANUFACTURER'S SPECIFICATIONS.
- 3. A FIRST FLUSH DEVICE IN ACCORDANCE WITH MANUFACTURER'S SPECIFICATIONS SHALL BE FITTED TO RAINWATER TANK SYSTEM TO FLUSH OUT THE FIRST 0.5mm OF RUN-OFF FROM THE ROOF AREA THAT DRAINED INTO THE TANK (E.G. 0.5L/m2).
- 4. RAINWATER OUTLET CONNECTIONS AS PER BASIX CERTIFICATE

# COMBINED RWT/OSD DETAILS OSD SL RWT V RWT H RWT TWL OSD V OSD H OSD TWL DIA RWT/OSD 8.60 1.00 m² 610 9.21 2.00 m² 1215 10.46

TANK SIZING					
Ī	TANK	HEIGHT	LENGTH	WIDTH	VOLUME
Ī	RWT/OSD	1860	2200	800	3.00 m³

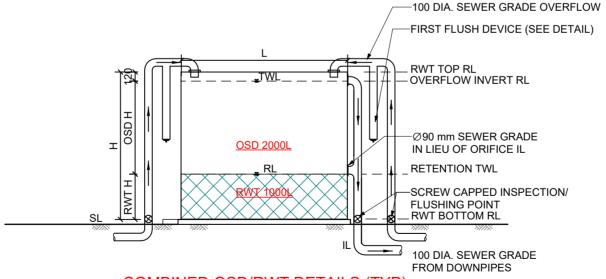

COMBINED OSD/RWT DETAILS (TYP)

SCALE: 1:50



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Revisions		
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STANDARD DETAILS (CON

PROJECT: PROPOSED NEW GRANNY FLAT

STANDARD DETAILS (CONT'D)

Project No: 6797H Issue: A Date: 20.11.2024 Drawing No: SD2